




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PLAN NOTES:


- ① RUN 4" EXHAUST DUCT TO SOFFIT GRILLE AS SHOWN.
- ② RUN REFRIGERANT PIPING UP IN STUD SPACE OF EXTERIOR WALL AND RUN THRU JOISTS TO FURNACE LOCATIONS ABOVE. RISE UP IN WALL OF MECHANICAL ROOM ABOVE. SEE SHEET M102 FOR CONT. OF PIPING.

SPECIAL NOTE:
 SEE LARGE SCALE PLANS ON SHEETS M200 FOR TYPICAL DUCTWORK AND MECHANICAL EQUIPMENT LAY-OUT FOR INDIVIDUAL TOWN HOME TYPES.



BUILDING "A" MAIN LEVEL MECHANICAL PLAN
 SCALE: 1/8" = 1'-0"

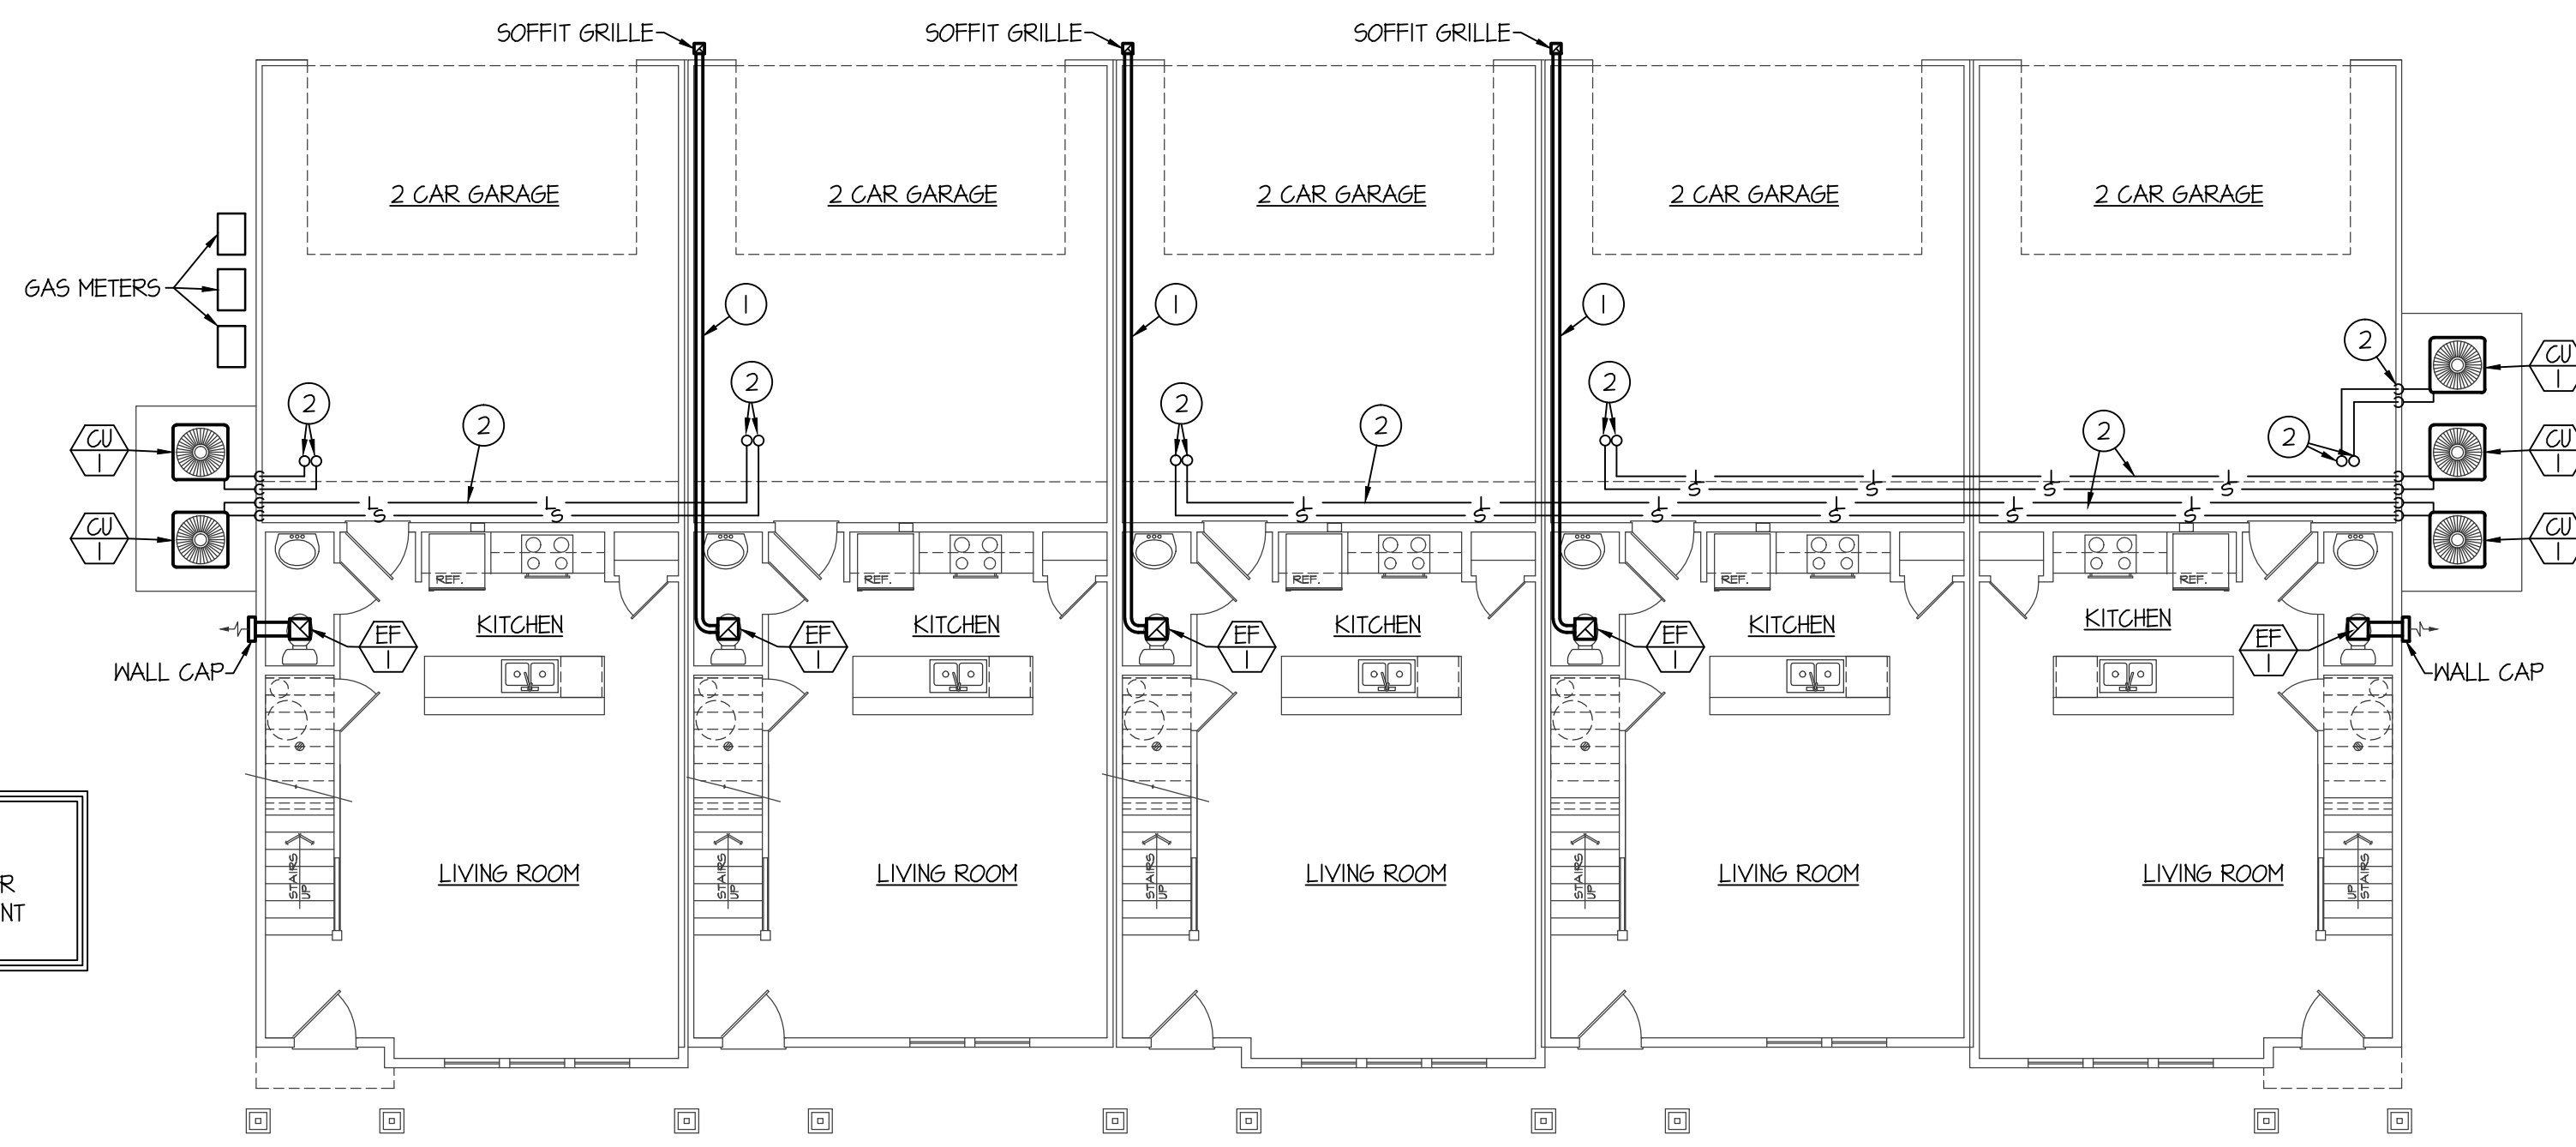SPECIAL NOTE:
 SEE LARGE SCALE PLANS ON SHEETS M200 FOR TYPICAL DUCTWORK AND MECHANICAL EQUIPMENT LAY-OUT FOR INDIVIDUAL TOWN HOME TYPES.

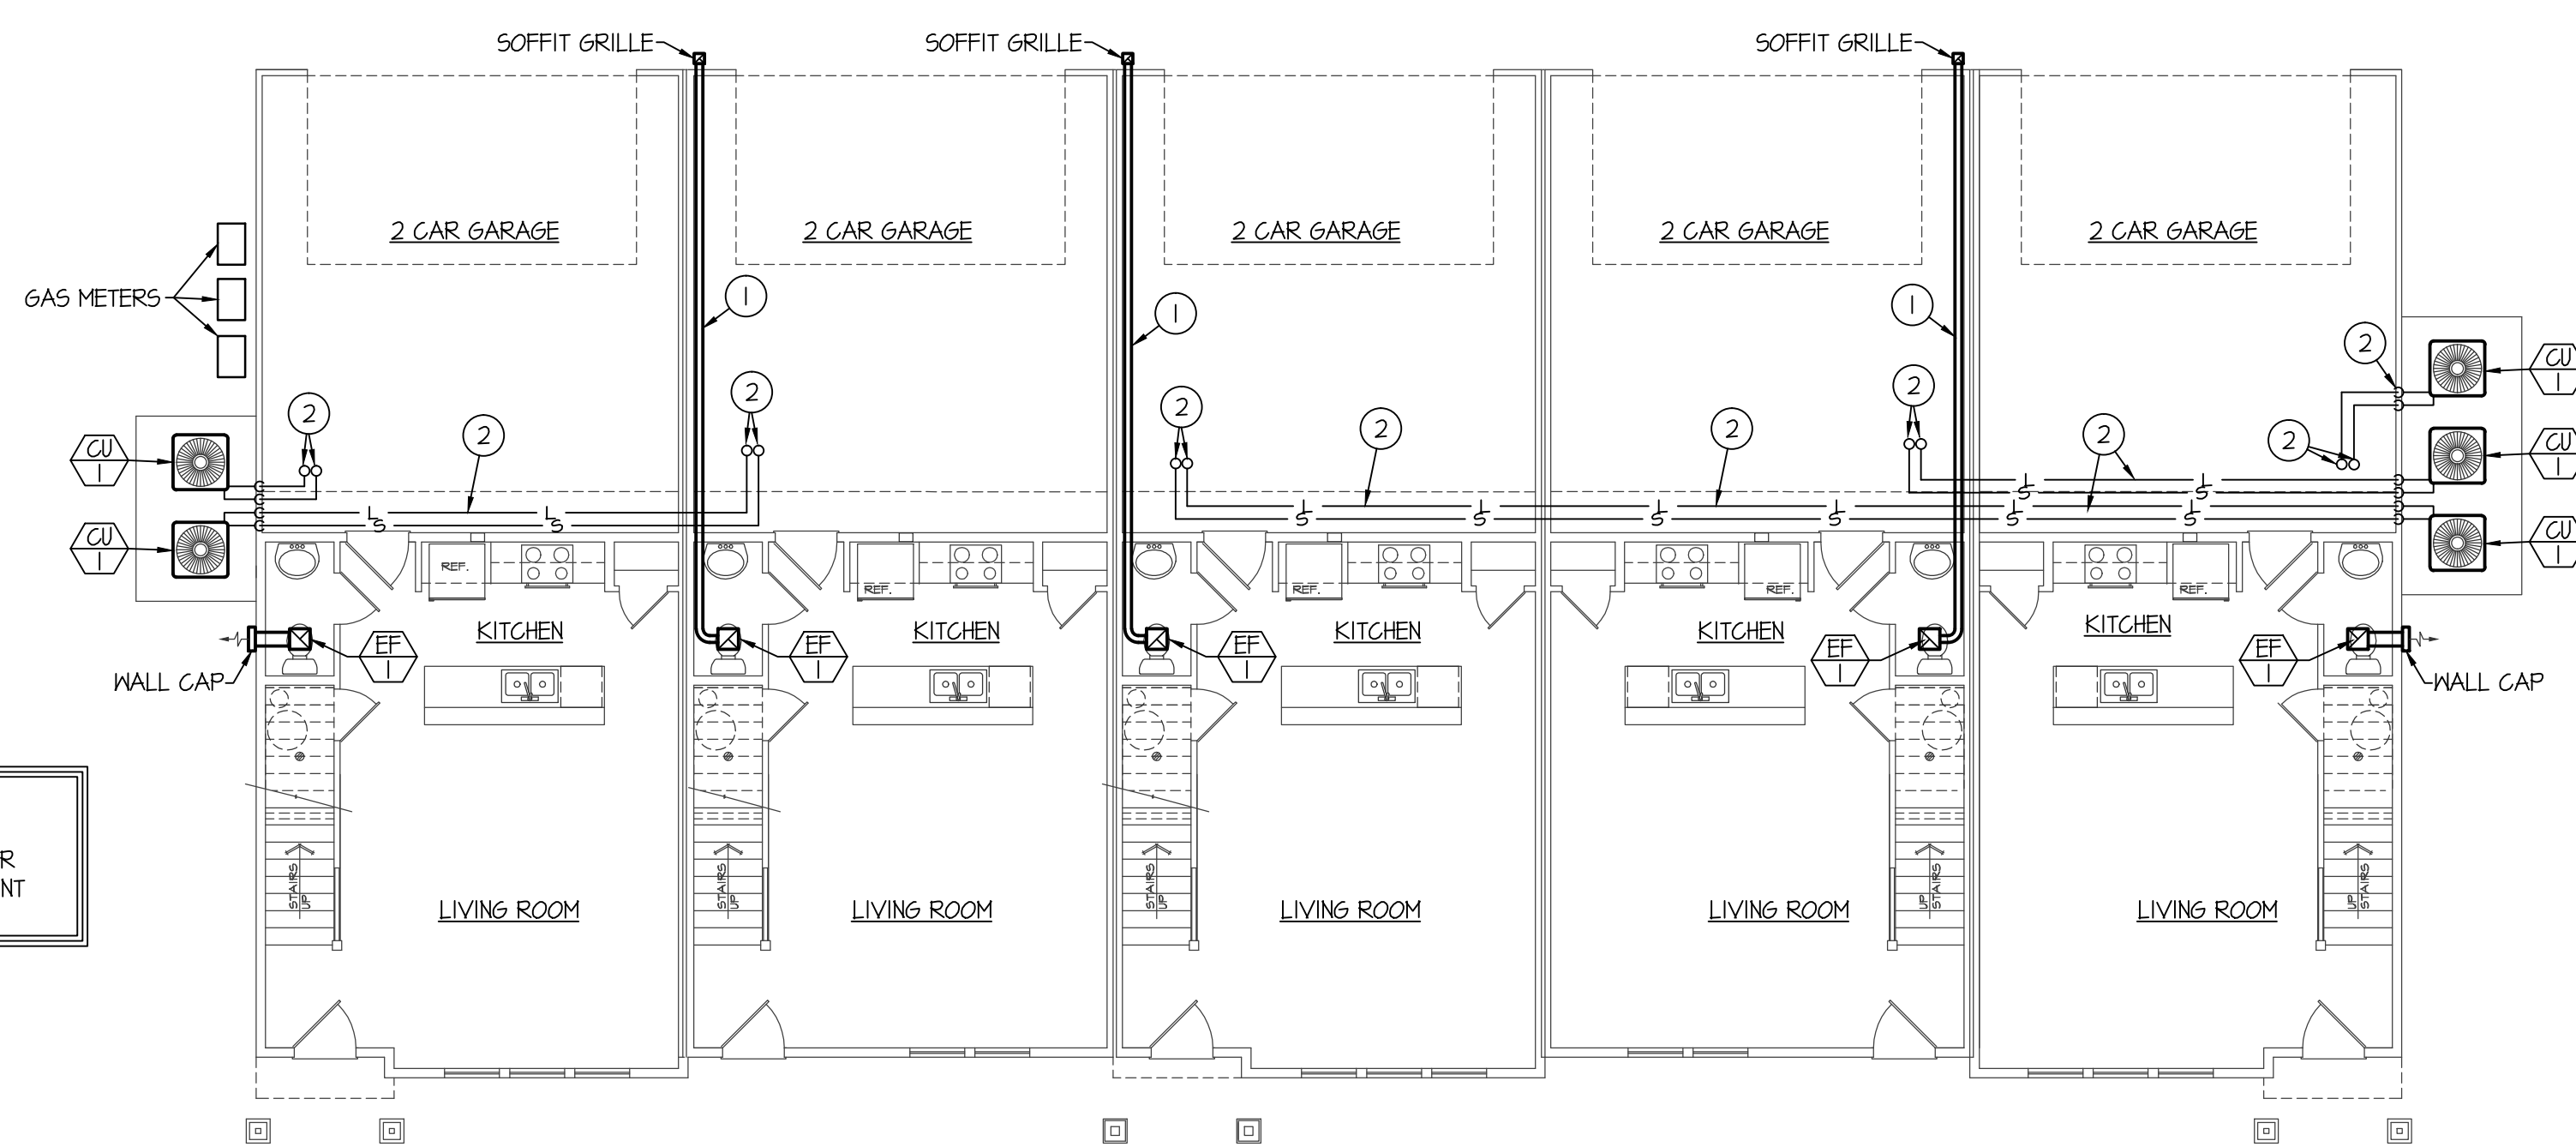


BUILDING "B" MAIN LEVEL MECHANICAL PLAN
 SCALE: 1/8" = 1'-0"

MECHANICAL LEGEND

SYMBOL	DESCRIPTION
①	ELECTRONIC THERMOSTAT
⊕	EQUIPMENT SYMBOL
⊞	RECTANGULAR SUPPLY AND RETURN AIR DUCT TAKE-OFF
⊞	TURNING VANES
⊞	DUCT TRANSITION
⊞	INSULATED FLEXIBLE DUCT
⊞	CEILING SUPPLY REGISTER
⊞	CEILING RETURN AIR GRILLE
⊞	CEILING MOUNTED EXHAUST FAN
⊞	GAS FURNACE WITH DX COOLING COIL

STRATA TOWNHOMES
 LOGAN, UTAH

PROJECT: STRATA TOWNHOMES
 SHEET TITLE: MAIN LEVEL MECHANICAL PLANS

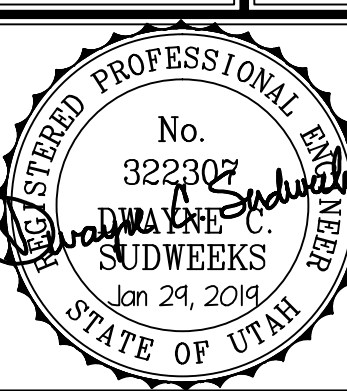

DRWN. BY: SR
 OKD. BY: DCS
 JOB NO: 18043
 DATE: DEC. 2018

SHEET: M101
 OF: THREE